23/2129CHOUSING DEVELOPMENT SITE LINLEY ROAD ALSAGER



Notes

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Refer to landscape architect drawings: Landscape GA Plan - 200000 Lanscape Planting Plan - 210000 Hardscape Plan - 200300

P6 05.07.24 PLANNING UPDATES JR P5 14.03.24 PLANNING UPDATES JR/JP JR/GH P4 25.05.23 PLANNING ISSUE P3 29.03.23 PLANNING ISSUE JR/GH P2 22.03.23 Draft Planning Issue JR P1 10.03.23 Draft Planning Issue JR Rev Date Description Drawn / Checked

Project name

LINLEY ROAD

PLUS DANE Drawing number 3845A - LB - LR - 00 - D - A - 110000 **P6** Drawing Proposed Site Plan Purpose of issue FOR PLANNING Date Scale 1 : 500 @ A1 **MAR 23** Client Plus Dane London Thane Studios 2-4 Thane Villas London N7 7PA +44 (0)20 7275 7676 Manchester Bonded Warehouse 18 Lower Byrom Street Manchester M3 4AP +44 (0)161 669 8740 Levitt Bernstein levittbernstein.co.uk

C:\Revit Local\3845A-Masterplan-R23-Central_jessica.rees884R3.rvt



Please read in accordanace with 3845A Plant schedule for detailed planting species for each mix.

Notes

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<u>NOTE</u>

Refer to Sutcliffe drawings for proposed highways work, proposed drainage and levels, further detail will be submitted as part of S278works appliction post planning

Refer to Rachel Hacking Ecology report for BNG calculation and ecological assessment

Refer to Jon Coe Tree AIA and tree constraint plan for existing trees to be removed or retained and the cellweb detail

External lighting design will be developed post planning

Ecological enhancement to be detailed with ecologist planning.

Landscape GA Plan Purpose of issue For Information Scale As indicated @ A1

3845A - LB - ZZ - XX - DP - L - 200000

Client PLUS DANE

Levitt Bernstein levittbernstein.co.uk

London Thane Studios 2-4 Thane Villas London N7 7PA +44 (0)20 7275 7676 Manchester Bonded Warehouse 18 Lower Byrom Street Manchester M3 4AP +44 (0)161 669 8740

Rev

P7

Suitability code

First issue date

29/03/23

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P7 05/07/24 PLANNING ISSUE EK/KD P6 27/06/24 Public Open Space Edits EK/KD P5 14/03/24 PLANNING UPDATES EK/KD EK/JR P4 25/05/23 PLANNING ISSUE P3 29/03/23 DRAFT PLANNING EK/DL P2 22/03/23 DRAFT PLANNING EK/DL EK/DL P1 14/03/23 Coordination Rev Date Description Drawn / Checked

Project name

Drawing number

Drawing

LINLEY ROAD PLUS DANE




	GENERAL NOTES
	THIS DRAWING SHOULD NOT BE SCALED FROM. ALL DIMENSIONS SHOULD BE TAKEN FROM RELEVANT DRAWINGS. IF NO DIMENSIONS ARE AVAILABLE THEN THE ENGINEER SHOULD BE CONTACTED FOR ADVICE.
	ALL DIMENSIONS SHOULD BE CHECKED ON SITE AND ANY DISCREPANCIES SHALL BE REPORTED TO THE ENGINEER PRIOR TO COMMENCEMENT OF WORKS. ALL WORKS RELATING TO PROPOSED SEWERS SHALL BE CARRIED OUT
	IN STRICT ACCORDANCE WITH THE DESIGN AND CONSTRUCTION GUIDANCE FOR FOUL AND SURFACE WATER SEWERS OFFERED FOR ADOPTION UNDER THE CODE FOR ADOPTION AGREEMENTS FOR WATER AND SEWERAGE COMPANIES OPERATING WHOLLY OR MAINLY IN ENGLAND ("THE CODE") AND SHALL BE REFERRED TO AS 'THE DCG.'
	THIS DRAWING SHALL BE READ IN CONJUNCTION WITH ALL OTHER RELEVANT DRAWINGS TO ENSURE THAT THE ADOPTED SEWERS (AS INDICATED ON THIS DRAWING) ARE CONSTRUCTED IN ACCORDANCE WITH THE DCG AND ALL STATUTORY UNDERTAKER AMENDMENTS.
	THE DEG AND ALL STATUTORT UNDERTAKER AMENDMENTS. THE DESIGN OF THE SEWERS AND OTHER ELEMENTS TO BE ADOPTED (AS INDICATED ON THIS DRAWING) HAVE BEEN DESIGNED IN ACCORDANCE WITH PARTS B, C AND D OF THE DCG. PUMPING STATION
N	DESIGNS WILL BE CARRIED OUT BY A SPECIALIST THIRD PARTY. THE CONSTRUCTION OF THE SEWERS TO BE ADOPTED (AS INDICATED ON THIS DRAWING) WILL BE ACCORDANCE WITH PARTS B TO F OF THE
	DCG. THE DEVELOPER WILL REMAIN RESPONSIBLE FOR THE SEWERS TO BE ADOPTED (AS INDICATED ON THIS DRAWING) UP TO THE TIME THE SEWERS ARE ADOPTED.
	IF ANY EXISTING SEWERS ARE LOCATED ON SITE DURING THE WORKS THE ENGINEER SHALL BE NOTIFIED. ANY UNKNOWN SEWERS LOCATED ON SITE SHALL NOT BE REMOVED UNTIL ADVISED OTHERWISE.
	THE DEVELOPER SHALL PROVIDE AN AS-BUILT SURVEY OF THE DRAINAGE TO THE ENGINEER UPON COMPLETION OF WORKS SO THAT AN AS-BUILT RECORD DRAWING CAN BE PREPARED.
	THE DEVELOPER SHALL PROVIDE A CDM HEALTH AND SAFETY FILE IN ACCORDANCE WITH THE GUIDANCE PROVIDED IN APPENDIX I OF THE DCG.
	PRIOR TO CONSTRUCTION THE CONTRACTOR IS TO ENSURE THAT THE PROPOSED DRAINAGE DOES NOT CLASH WITH THE EXISTING SERVICES. THE CONTRACTOR IS TO ALLOW FOR THIS PROVISION WITHIN THE TENDER SUM.
	THE CONTRACTOR SHALL BE RESPONSIBLE FOR ATTAINING ALL NECESSARY APPROVALS FOR ANY SERVICE DIVERSIONS REQUIRED TO FACILITATE THE PROPOSED WORKS
	S104 DRAINAGE KEY site boundary
	NEW S104 COMBINED SEWER NEW S104 SURFACE WATER SEWER NEW S104 FOUL WATER SEWER PROPOSED SURFACE WATER RISING MAIN
CARDWAY SITE	NEW MANHOLE - REFER TO PLAN FOR SIZE
Ħ	EX COM EX COMBINED DRAIN/SEWER EX SW EX SURFACE WATER DRAIN/SEWER EX FW EX FOUL WATER DRAIN/SEWER
	X X EX DRAINAGE TO BE ABANDONED
	NOTE: ALL DRAINAGE CONNECTIONS SHALL BE SOFFIT TO SOFFIT UNLESS DETAILED/NOTED OTHERWISE
	NOTE: NO ADOPTABLE WORKS SHALL BE CARRIED OUT UNTIL FULLY APPROVED BY ADOPTING AUTHORITY. ANY WORKS CARRIED OUT PRIOR TO APPROVAL WILL BE UNDERTAKEN AT CONTRACTORS RISK.
	NOTE: CONCRETE PROTECTION SHALL BE GRADE GEN 3 (C16/C20) COMPLYING WITH BRE SPECIAL DIGEST 1.
	P03 UPDATED TO SUIT NEW SITE LAYOUT 31.01.24 JW DS
	P02UPDATED TO SUIT NEW SITE LAYOUT29.01.24JWDSP01ISSUED FOR COMMENT28.06.23AJBDSRevDescriptionDateByChkdDrawing Status
	PRELIMINARY DRAWING Sutcliffe Sutcliffe Prelaning Surveying Pre
	Liverpool Head Office: Manchester Office: North Wales Office: London Office: 0151 227 3155 0161 817 5180 01978 664 071 020 8016 4320 www.sutcliffe.co.uk Image: Comparison of the comparis
	PLUS DANE GROUP Project LINLEY ROAD
	ALSAGER
	Drawing Title S104 DRAINAGE LAYOUT
	Date Drawn By Checked By JUNE. 2023 AJB DS
SCALE BAR 1:250	Scale at A0 Project Number 1:250 30864 Sheet Number Revision
R 0 5 10 15 20	30864-SUT-ZZ-XX-DR-C-6550 P03



1 External Material Intent - Elevation A-

1 : 100

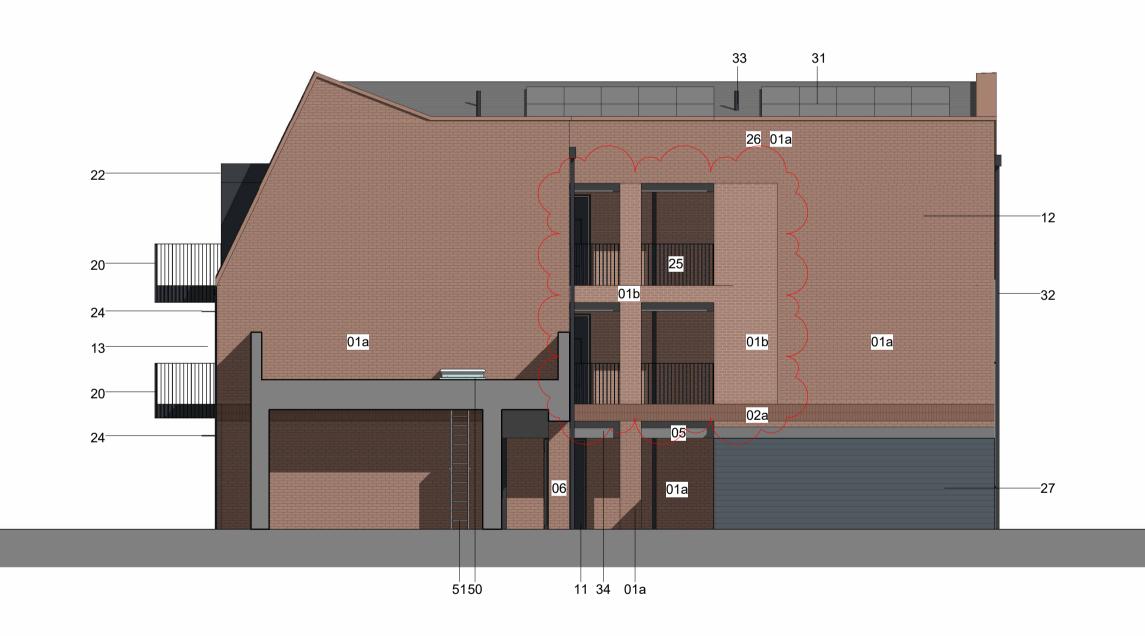

3 External Material Intent - Elevation C -

1:100

5n 1m 2m 3m 4m

Notes

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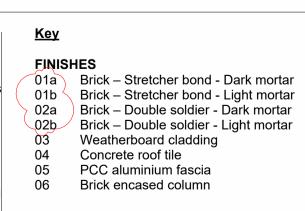
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COMPONENTS

- Private external doorset 10 Communal external doorset 11 12 Window – residential 13 Patio doorset – brick reveal
- 14 French doorset
- 15 AOV window 16 Window – fixed
- 17 Curtain walling / Entrance doorset 18 Metal louvred doorset

ELEMENTS

20 21 22 23 24 25 26 27 28 29	Balconies with balustrade and top b Entrance canopy - PPC aluminium Balcony canopy – PPC alumunium Juliet balcony balustrade formed of Perforated metal solar shading Walkway balustrade and top bar for Brick parapet Bin store Cycle store (minimum capacity: 11 o Projecting window lining (anthracite
29	Projecting window inning (antinactie
MEPH	
30	Dry riser inlet
31	PV panels
32	PPC Metal RWP and hopper
33	SVP roof vent
34	MVHR vent within fascia.
ACCE	SS & MAINTENANCE
50	Roof access hatch
51	Cat ladder



2 | External Material Intent - Elevation B -1 : 100



4 | External Material Intent - Elevation D -1:100

top bar formed of 50x10 PPC MS flats.

d of 50x10 PPC MS flats

formed of 50x10 PPC MS flats.

/: 11 cycles) racite to match window frames)


GENERAL NOTES

Windows / Doorsets to have brick reveals within brickwork walls and

aluminium linings within weatherboard cladding. 2. Landscape and boundary treatments as per Landscape Architect

design

P6	14/03/24	PLANNING U
P5	25/05/23	PLANNING I
P4	29/03/23	PLANNING I
P3	22/03/23	Draft Plannin
P2	28/02/23	Lift removed
P1	10/02/23	Preliminary
Rev	Date	Description

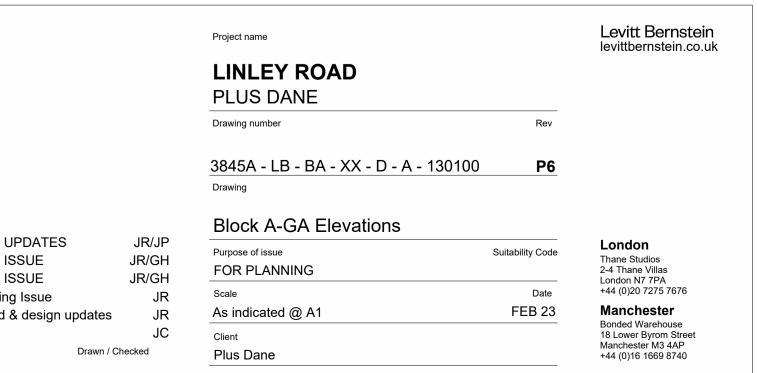

ILKE HOUSE TYPE | HOLT-A & A.w





2 Holt-A & A.w Front Elevation - Material Intent 1:50



1 Holt-A & A.w Rear Elevation - Material Intent 1:50

3 | Holt-A.w Side Elevation - Material Intent 1:50

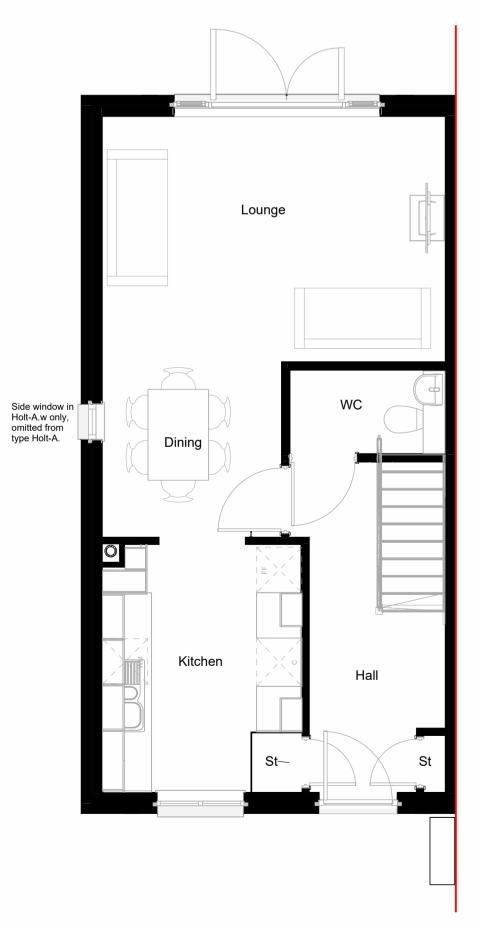

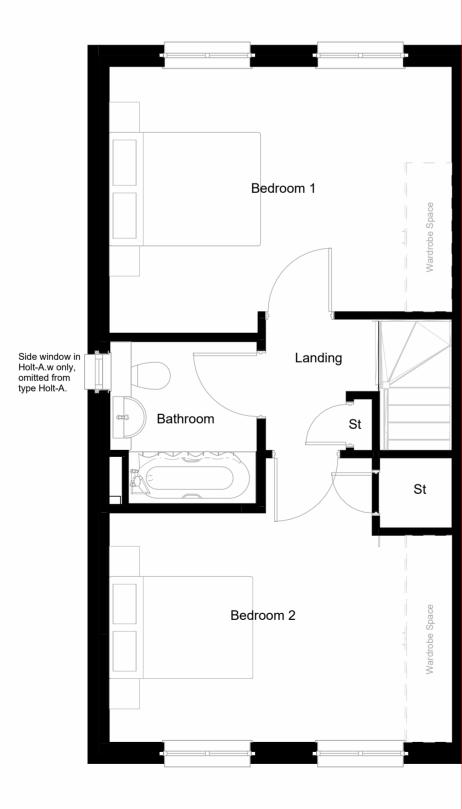

_ _ _ _ _ _ _ _ _ _ _ _ _ _ _ _ _ Indicative PV zone - dashed _ _ _ _ _ _ _ _ _ _ _ _ _ _ _ _ Indicative PV zone - dashed

5 | Holt-A & A.w First Floor Plan

1:50

1:50

GF



1:50

4 | Holt-A & A.w Ground Floor Plan



7 Holt-A Side Elevation - Material Intent

1:50

Holt-A & A.w End/Mid plot Roof: Standard 30deg
L00 Elevation: Brick slip L01 Elevation: Brick slip • Side Window: Holt-A [NO] / Holt-A.w [YES] Holt-B End plot
Roof: Front 46deg gable
L00 Elevation: Brick slip
L01 Elevation: Brick slip Side Window: No Holt-C & C.w End/Mid plot
Roof: Standard 30deg
L00 Elevation: Brick slip L01 Elevation: Render • Side Window: Holt-C [NO] / Holt-C.w [YES] Holt-D End/Mid plot
Roof: Standard 30deg
L00 Elevation: Brick slip L01 Elevation: Weatherboard Side Window: No Holt- E.w End plot
Roof: Standard Front gable 46deg
L00 Elevation: Brick slip L01 Elevation: Weatherboard Side Window: Yes

Area Schedule (GIA) - House Sub-Types - Holt A, A.w					
Number	llke Sub-Type	GF Elevation	Upper Elevation.	Side Window	Upgraded acoustic trickle vents
A6	Holt-A	Brick Slip	Brick Slip	No	
B2	Holt-A	Brick Slip	Brick Slip	No	
B3	Holt-A	Brick Slip	Brick Slip	No	
B4	Holt-A	Brick Slip	Brick Slip	No	
B5	Holt-A	Brick Slip	Brick Slip	No	
Holt-A: 5	-	•			
A7	Holt-A.w	Brick Slip	Brick Slip	Yes	
Holt-A.w: 1	1				
Grand total: 6					

6 | Holt-A & A.w Roof Plan

Notes

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Elevation Material Key

Red brick - soldier course datum

- Red brick stretcher course
- - Weatherboard anthracite

Render - off white

RWP, Fascia fittings & Windows - anthracite

P	°5	25.05.23	PLANNING ISSUE - Ilke updat	es JR/GH
P	' 4	29.03.23	PLANNING ISSUE	JR/GH
P	2	22.03.23	Draft Planning Issue	JR
P	2	10.03.23	Draft Planning Issue	JR
P	י1	28.02.23	llke Types - draft issue	JR
R	ev	Date	Description D	rawn / Checked

Project name

LINLEY ROAD

PLUS DANE Drawing number 3845A - LB - IH - XX - D - A - 120300 P5 Drawing House Type - Holt-A & A.w Purpose of issue FOR PLANNING Date Scale 1 : 50 @ A1 01/16/23 Client Plus Dane London Thane Studios 2-4 Thane Villas London N7 7PA +44 (0)20 7275 7676


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Manchester Bonded Warehouse 18 Lower Byrom Street Manchester M3 4AP +44 (0)161 669 8740

ILKE HOUSE TYPE | HOLT-C & C.w





2 Holt-C & C.w Front Elevation - Material Intent 1:50

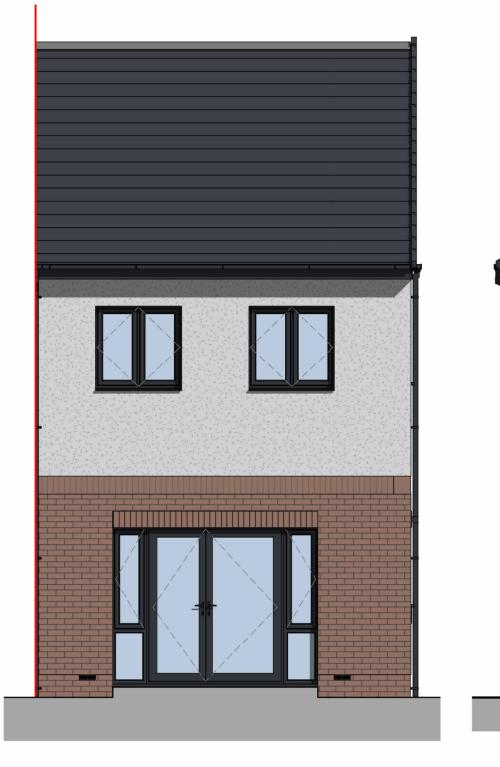

1 | Holt-C & C.w Rear Elevation - Material Intent 1:50

1:50

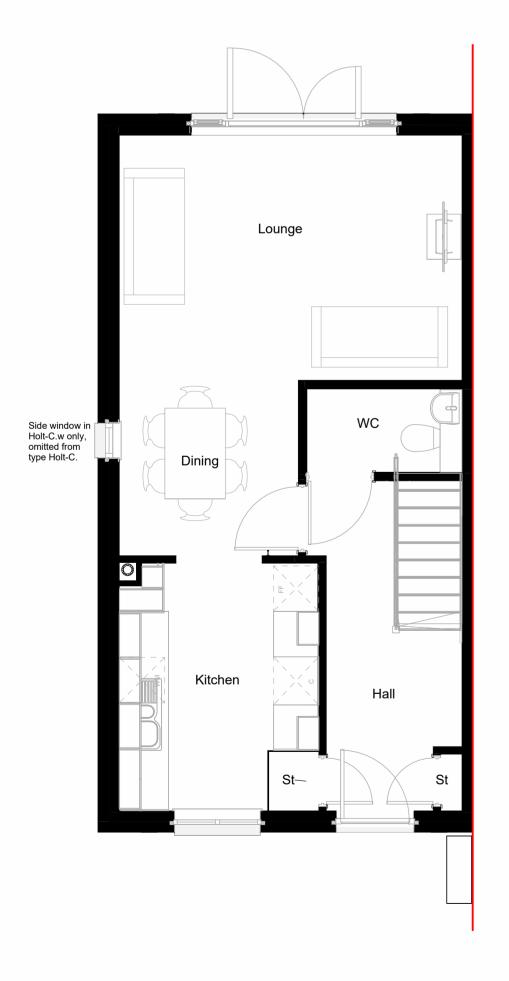

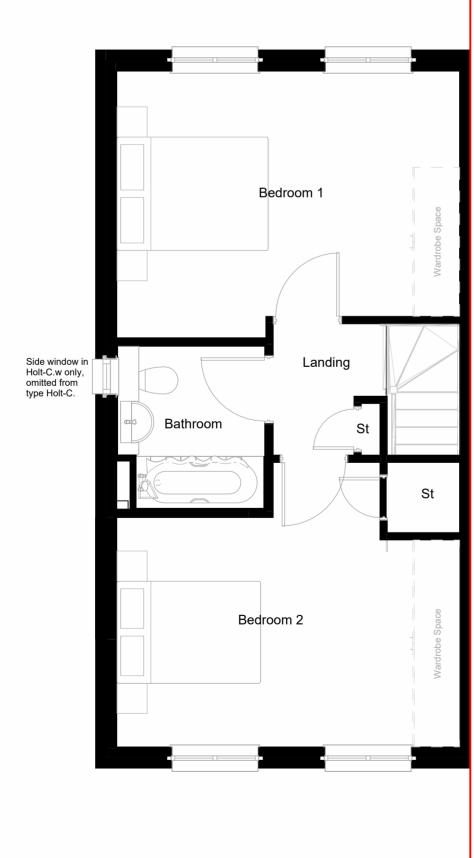

GF





3 Holt-C & C.w Side Elevation - Material Intent

_	
1	
_	
_	
	I
1	Indicative PV zone - dashed

6 | Holt-C & C.w Roof Plan 1:50

Holt-B

Holt-C & C.w

Holt-D

Holt-A & A.w

 End/Mid plot Roof: Standard 30deg
L00 Elevation: Brick slip L01 Elevation: Brick slip Side Window: Holt-A [NO] / Holt-A.w [YES]

End plot
Roof: Front 46deg gable
L00 Elevation: Brick slip L01 Elevation: Brick slip Side Window: No

End/Mid plot
Roof: Standard 30deg
L00 Elevation: Brick slip L01 Elevation: Render
Side Window: Holt-C [NO] / Holt-C.w [YES]

End/Mid plotRoof: Standard 30deg L00 Elevation: Brick slip L01 Elevation: Weatherboard Side Window: No

Holt- E.w

End plot
Roof: Standard Front gable 46deg
L00 Elevation: Brick slip L01 Elevation: Weatherboard Side Window: Yes

le (GIA) - House Sub-Types - Holt C				
ation	Upper Elevation.	Side Window	Upgraded acoustic trickle vents	
	Render	No		
	Render	No		
	Render	No	Yes	
	Render	No	Yes	
	Render	No	Yes	
	Render	Yes		
	Render	Yes	Yes	
	Render	Yes	Yes	
	Render	Yes	Yes	

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Elevation Material Key

Red brick - soldier course datum

Red brick - stretcher course

_ __

Weatherboard - anthracite

Render - off white

RWP, Fascia fittings & Windows - anthracite

P5	25.05.23	PLANNING ISSUE - Ilke updat	es JR/GH
P4	29.03.23	PLANNING ISSUE	JR/GH
P3	22.03.23	Draft Planning Issue	JR
P2	10.03.23	Draft Planning Issue	JR
P1	28.02.23	llke Types - draft issue	JR
Rev	Date	Description D)rawn / Checked

Project name

LINLEY ROAD

PLUS DANE Drawing number Rev 3845A - LB - IH - XX - D - A - 120302 Р5 Drawing House Type - Holt-C & C.w Purpose of issue FOR PLANNING Date Scale 1 : 50 @ A1 01/16/23 Client Plus Dane London Thane Studios 2-4 Thane Villas London N7 7PA +44 (0)20 7275 7676 Manchester

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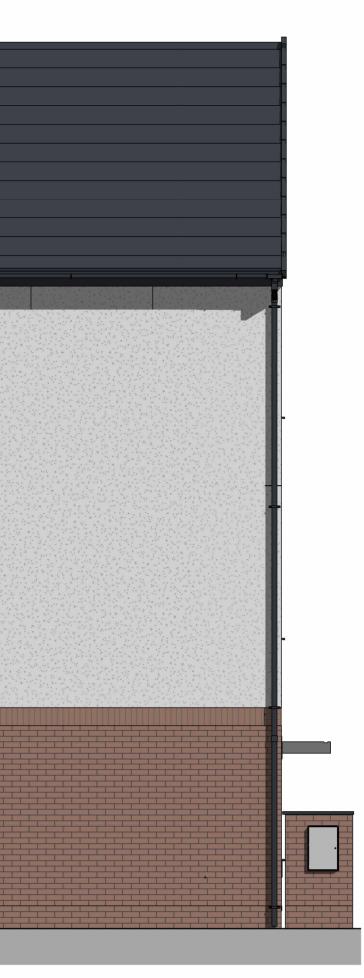
1F

Rockingham-A & A.w	

- Side Window: Rockingham-A [NO] / Rockingham-A.w [YES]

	Area Schedu	lle (GIA) - House	e Sub-Types - R	ockingham	A
Number	llke Sub-Type	GF Elevation	Upper Elevation.	Side Window	aco
		•			
B9	Rockingham-A	Brick Slip	Render	No	
B10	Rockingham-A	Brick Slip	Render	No	
B11	Rockingham-A	Brick Slip	Render	No	
Rocking	ham-A: 3		,		
B8	Rockingham-A.w	Brick Slip	Render	Yes	
Dealding	a a ma A 14/1 1	•			

2F



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Elevation Material Key

Red brick - soldier course datum

Red brick - stretcher course

Weatherboard - anthracite

Render - off white

RWP, Fascia fittings & Windows - anthracite

P5	25.05.23	PLANNING ISSUE - Ilke upda	tes JR/GH
P4	29.03.23	PLANNING ISSUE	JR/GH
P3	22.03.23	Draft Planning Issue	JR
P2	10.03.23	Draft Planning Issue	JR
P1	28.02.23	llke Types - draft issue	JR
Rev	Date	Description	Drawn / Checked

Project name

LINLEY ROAD

PLUS DANE

Drawing number 3845A - LB - IH - XX - D - A - 120330 Ρ5

Drawing

House Type - Rockingham-A & A.w Purpose of issue

FOR PLANNING

1 : 50 @ A1

Scale

Client Plus Dane

London Thane Studios 2-4 Thane Villas London N7 7PA +44 (0)20 7275 7676 Manchester Bonded Warehouse 18 Lower Byrom Street Manchester M3 4AP +44 (0)161 669 8740

Date

01/18/23

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Upgraded

vents

Side acoustic trickle

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ILKE HOUSE TYPE | THETFORD-A & A.w




1 : 50




2 | Thetford A & A.w Rear Elevation - Material Intent




3 | Thetford A.w S 1 : 50

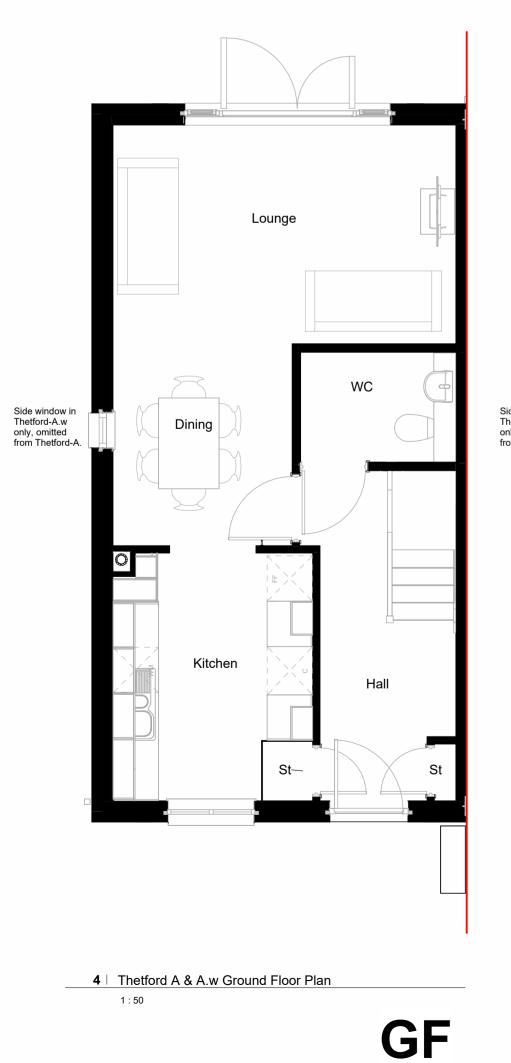

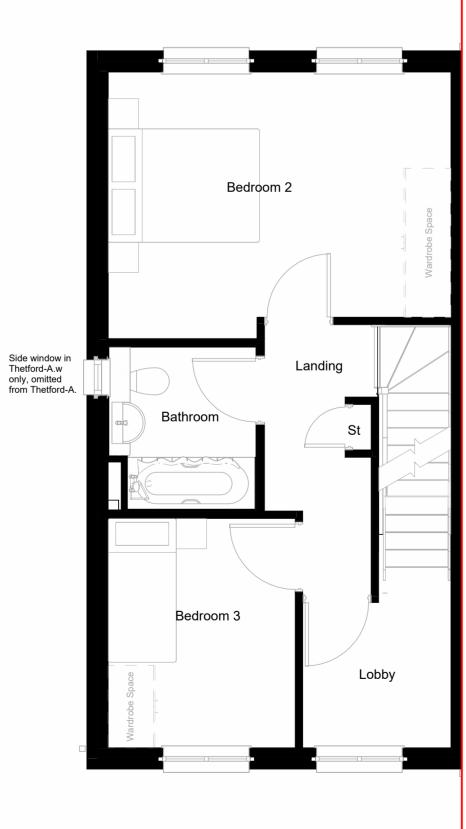


5 | Thetford A & A.w First Floor Plan

1:50

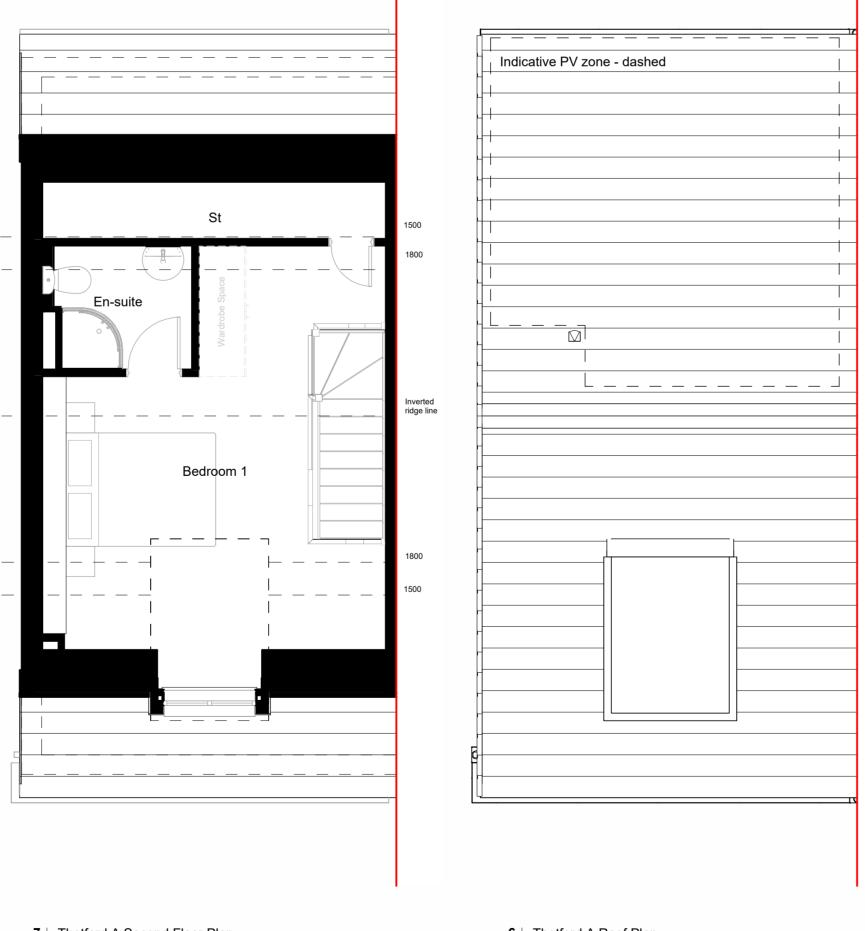

7 | Thetford A Second Floor Plan

3 | Thetford A.w Side Elevation - Material Intent

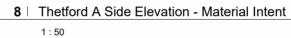

Thetford-A & A.w					
 End/Mid Plot Roof: Room in roof 35deg L00 Elevation: Brick slip L01 Elevation: Brick slip Side Window: Thetford-A [NO] / Thetford-A.w [YES] 					
	Thetford-B & B.w				
 Thetford-B & B.w End/Mid plot Roof: Room in roof 35deg L00 Elevation: Brick slip L01 Elevation: Render Side Window: Thetford-B [NO] / Thetford-B.w [YES] 				ord-B.w [YES]	
Area Schedule (GIA) - House Sub-Types - Thetford A					
llke Sub-Type	GF Elevation	Upper Elevation.	Side Window	Upgraded acoustic trickle vents	

Number	llke Sub-Type	GF Elevation	Upper Elevation.	Side Window	Upgraded acoustic trickle vents
C3	Thetford-A	Brick Slip	Brick Slip	No	
C4	Thetford-A	Brick Slip	Brick Slip	No	
C5	Thetford-A	Brick Slip	Brick Slip	No	
C9	Thetford-A	Brick Slip	Brick Slip	No	
C10	Thetford-A	Brick Slip	Brick Slip	No	
C11	Thetford-A	Brick Slip	Brick Slip	No	
E2	Thetford-A	Brick Slip	Brick Slip	No	
E3	Thetford-A	Brick Slip	Brick Slip	No	
Thetford-A:	8		•	1	·
C2	Thetford-A.w	Brick Slip	Brick Slip	Yes	
C12	Thetford-A.w	Brick Slip	Brick Slip	Yes	
E1	Thetford-A.w	Brick Slip	Brick Slip	Yes	

6 │ Thetford A Roof Plan 1:50

Notes

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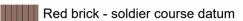
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Elevation Material Key



- Red brick stretcher course
- 20.30
- Render off white
- Weatherboard anthracite

RWP, Fascia fittings & Windows - anthracite

P5	25.05.23	PLANNING ISSUE - Ilke updat	tes JR/GH
P4	29.03.23	PLANNING ISSUE	JR/GH
P3	22.03.23	Draft Planning Issue	JR
P2	10.03.23	Draft Planning Issue	JR
P1	28.02.23	Ilke Types - draft issue	JR
Rev	Date	Description [Drawn / Checked

Project name

LINLEY ROAD

PLUS DANE
Drawing number
3845A - LB - IH - XX - D - A - 120320
Drawing
House Type - Thetford-A & A.w
Purpose of issue
FOR PLANNING

^{Scale} 1 : 50 @ A1

^{Client} Plus Dane

2110

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